



KEYED WORK NOTES (RE:DETAILS FOR ADDITIONAL INFORMATION)


- NEW BRICK VENEER w/GALV ADJ ANCH SYS 16" OC VERT, 32" OC HORIZ
- PREFINISHED METAL HORIZONTAL WALL PANELS & TRIM SYSTEM RE: B9/AE501
- ALUMINUM COMPOSITE METAL (ACM) PANEL SYSTEM
- PREFINISHED METAL ROOF / WALL FLASHING
- PREFINISHED METAL FASCIA
- PREFINISHED METAL GUTTER & DOWNSPOUT (TIE DOWNSPOUTS INTO STORM WATER SYSTEM)
- PREFINISHED 1-1/2" STANDING SEAM METAL ROOF PANEL
- ALUMINUM COMPOSITE METAL (ACM) PANEL CANOPY SYSTEM
- ALUMINUM STOREFRONT SYSTEM, SEE FLOOR PLAN FOR TYPE
- ALUMINUM ENTRANCE DOOR
- INSULATED HOLLOW METAL DOOR AND FRAME, PAINT
- REPLACE EXISTING GUTTER & DOWNSPOUT W/PREFINISHED METAL GUTTER & DOWNSPOUT (TIE DOWNSPOUTS INTO STORM WATER SYSTEM & REPAIR/MODIFY EXISTING ROOF CONNECTION)
- LOUVER - BLANK OFF UNUSED PORTIONS
- 1-1/2" EXPANSION JOINT AND COVER
- ICE CLEATS
- SUNSHADE BY STOREFRONT MANUFACTURER
- CONTINUOUS ICE AND WATER SHIELD MEMBRANE
- R-30, 5 1/2" NAIL BASE ROOF INSULATION (EXTEND WD DECK OVER TOP OF FASCIA BLOCKING)
- 1 1/2" GALV METAL ROOF DECK
- CONTINUOUS BENT PLATE OR ANGLE SUPPORT, RE: STRUC
- CONTINUOUS TREATED WOOD FRAMING
- CONTINUOUS PREFINISHED METAL SOFFIT & TRIM RE: B7/AE501
- 1-1/2" GALV METAL 2" FURRING, 16" O.C., ANCHOR SECURELY TO INSULATED BACKUP PANEL CLIPS PER PANEL MANUF SPECIFICATIONS
- 2" INSULATED CORE METAL WALL BACKUP PANEL SYSTEM (R-14) W/FLEXIBLE MEMBRANE FLG AND FASTENER SEAL, PER MANUF, ANCHOR SECURELY 16" O.C. PER MANUF, TYPICAL
- EXTERIOR 6" x 18 GA GALV METAL STUDS, 16" O.C. W/CONT TRACK AT ENDS, NOTE: AT BLDGS "B & C", INSTALL STUD SUPPORT CLIPS AT EXIST CMU WALLS (WHERE OFFSET) TO MEET OR EXCEED STUD L2600 STIFFNESS RATIO
- FLUID APPLIED VAPOR PERMEABLE MEMBRANE AIR BARRIER
- CONTINUOUS 2" RIGID INSULATION W/LAPPED EDGES, ANCHOR SECURELY TO WALL PER MANUF
- SPRAYED CELLULOSE INSULATION, FILL STUD DEPTH & ALL CAVITIES AT INSULATED WALLS, PROVIDE SUPPORT BLOCKING AS REQUIRED BY MANUF
- 5/8" GYPSUM WALLBOARD, REFER TO LIFE SAFETY PLAN FOR RATED GWB LOCATIONS
- 5/8" GYPSUM WALLBOARD CEILING ON 1-1/2" x 18 GA HAT CHANNELS, 24" O.C. WITH R-30 SPRAYED CELLULOSE INSULATION ABOVE, ANCHOR CHANNEL SECURELY AT EACH EXISTING ROOF TRUSS JOIST. (NOTE: AT 48" O.C., ANCHOR CHANNELS SECURELY WITH ONE S.S. ALL-THREAD ROD 24" x 3/8" DIA. AND TWO STRUC S.S. NUTS WITH PLATE WASHERS SIZED FOR INSTALLATION NEAR TRUSS PANEL POINTS BETWEEN JOIST BARS OR ANGLES AT BOTTOM CHORD. HANG REMAINDER OF ROD BELOW CEILING FOR FULL SUPPORT OF LOWER CEILING, MEP SYSTEMS, SEISMIC OR OTHER BRACING, APURTURANCES & OTHER LOADS)
- CONTINUOUS SEALANT AND BACKER ROD
- FINISH CEILING, RE: REFLECTED CEILING PLAN
- NEW STRUC SUPPORT MEMBER, RE: STRUC
- EXTERIOR 3 5/8" x 18 GA GALV METAL STUDS, 16" O.C. W/CONT TRACK AT ENDS
- INTERIOR 3 5/8" x 20 GA GALV METAL STUDS, 16" O.C. W/CONT TRACK AT ENDS
- INTERIOR 7/8" x 20 GA GALV METAL HAT CHANNELS, 16" O.C.
- GALVANIZED ADJUSTABLE ANCHORING SYSTEM AT MET WALL PANEL JOINT CLIPS & ON PANEL FACE BETWEEN. INSTALL PER MET WALL PANEL MANUFACTURER'S WARRANTED SYSTEM
- EXTERIOR 8" x 18 GA GALV METAL STUDS, 16" O.C. W/CONT TRACK AT ENDS.
- EXISTING ROOF TO REMAIN
- EXISTING STRUCTURE TO REMAIN
- EXISTING MASONRY WALL TO REMAIN
- NEW LINTEL(S)
- HOLLOW METAL FRAME
- INSULATED HOLLOW METAL DOOR
- METAL THRESHOLD - SET IN SEALANT BED
- MEMBRANE FLASHING
- SYNTHETIC SILL - BULLNOSE EDGE
- PREFINISHED METAL SILLS
- FLOOR FINISH
- BASE
- VAPOR BARRIER (10 MIL MINIMUM THICKNESS)
- VOID FORMS, REFER TO STRUCTURAL
- INTERIOR FURRING: 5/8" GWB ON 2 1/2" x 20 GA GALV METAL FRAMING, 16" O.C. W/CONT TRACK AT ENDS
- CONT 3/4" TREATED EXTERIOR PLYWOOD SHEATHING OR DECKING
- CONCRETE SLAB ON 10 MIL VAPOR BARRIER & MIN 4" COMPACTED DRAINAGE FILL, RE:STRUC

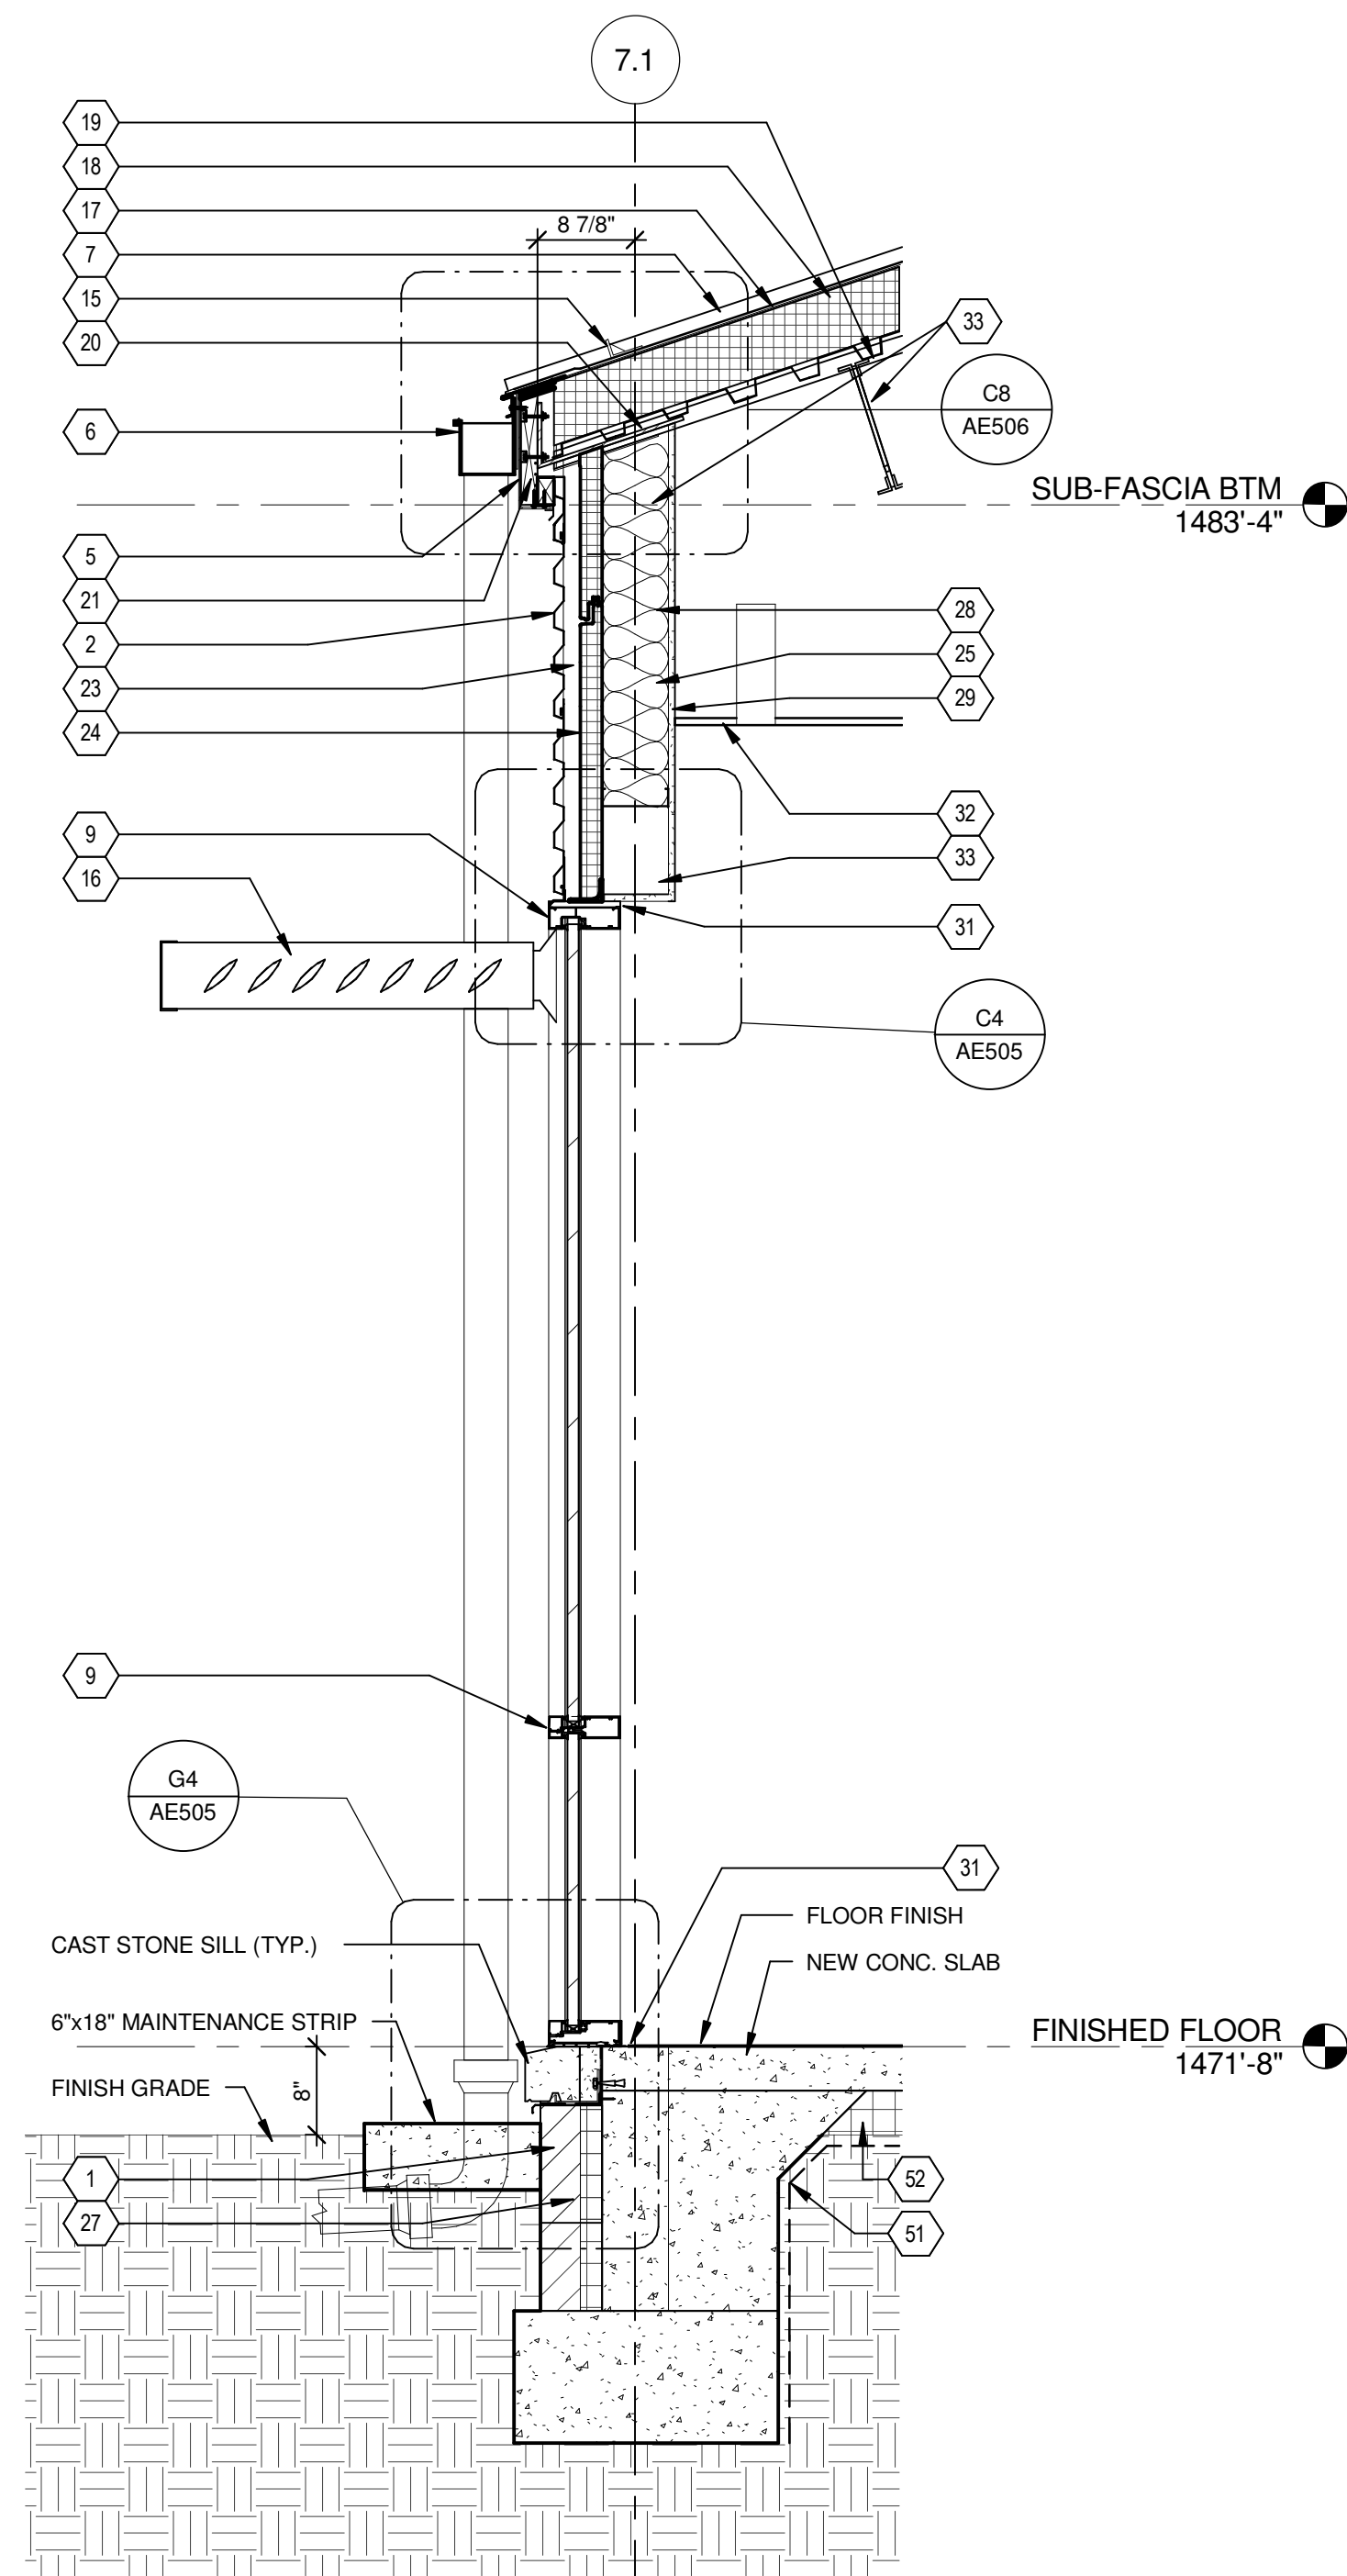

G1 WALL SECTION @ CORRIDOR 135
3/4" = 1'-0"

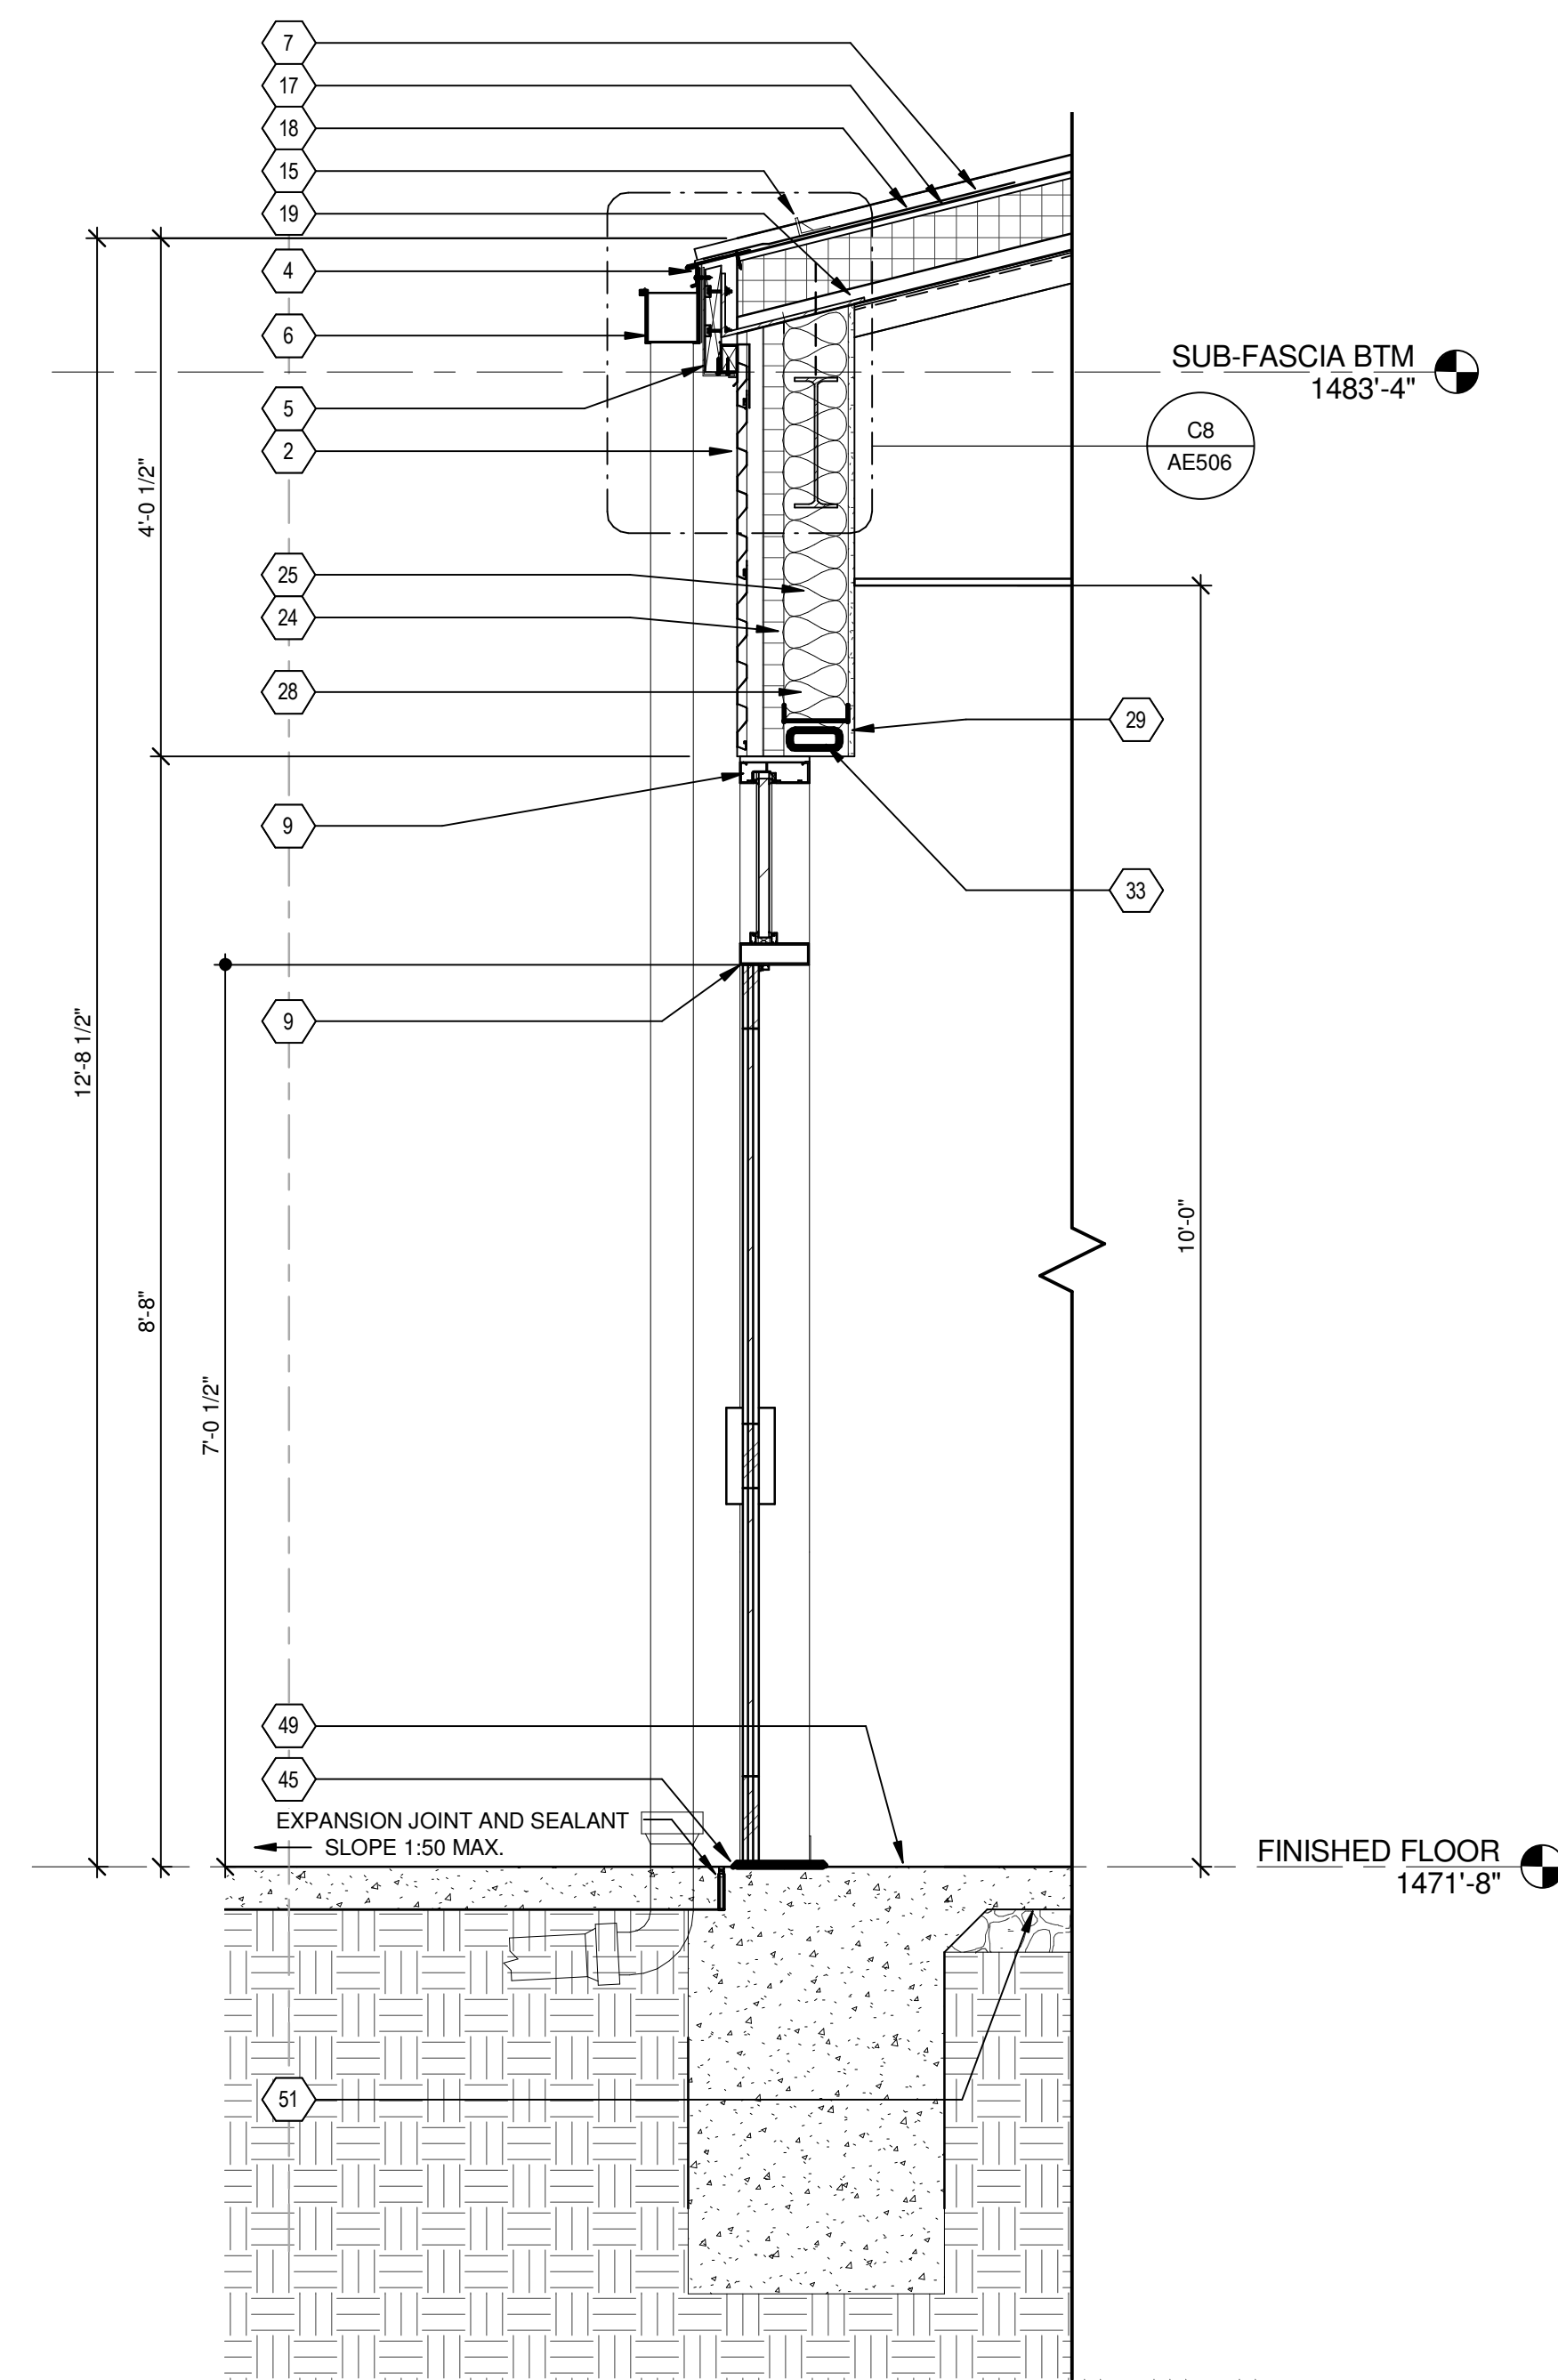

G4 WALL SECTION @ CORRIDOR 145
3/4" = 1'-0"

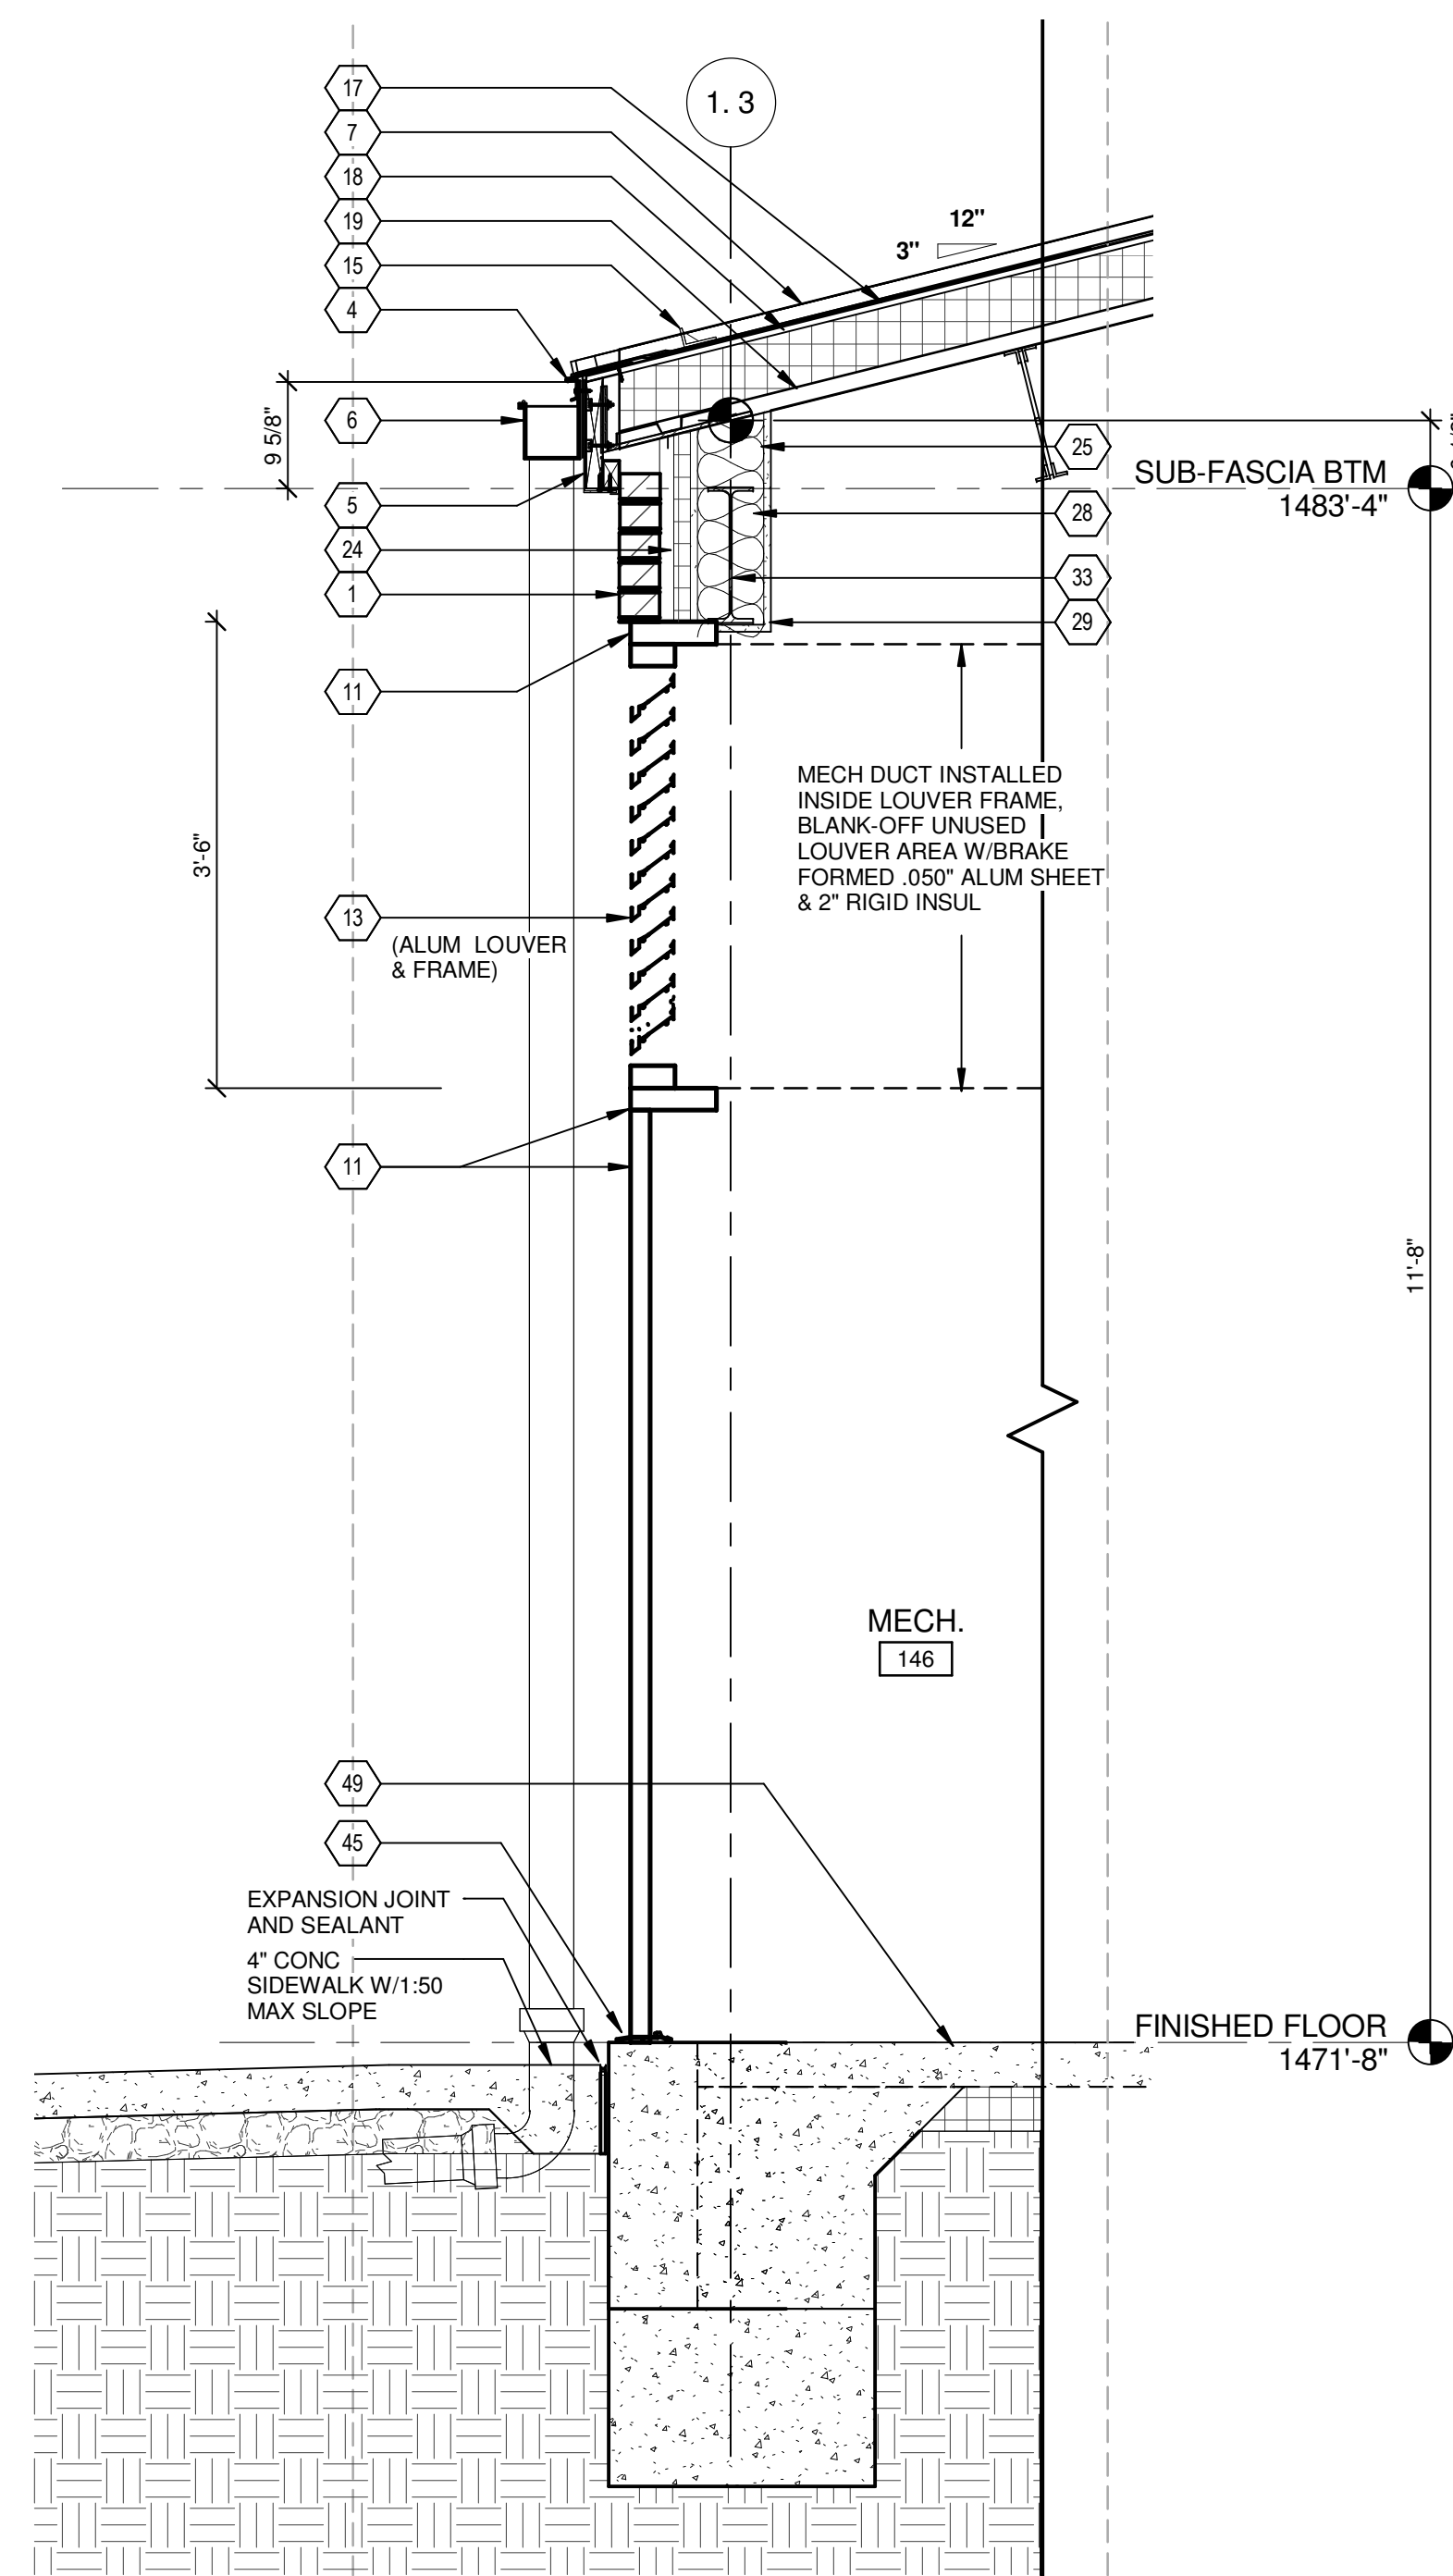

G6 WALL SECTION @ MECHANICAL 146
3/4" = 1'-0"

CONSULTANTS:		09/07/2012	ARCHITECT / ENGINEERS:		Drawing Title WALL SECTIONS	Project Title Renovate Leroy Pond Army Reserve Center for Mental Health Residential Rehabilitation Treatment/ Police Training		Project Number 564-341	Office of Facilities Management DEPARTMENT OF VETERANS AFFAIRS
					Approved: Project Director	Location Fayetteville, AR		Building Number	
						Date 9/7/12	Checked SG	Drawn PQ	
Revisions:		Date						Dwg. 66 of 126	

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100% CONSTRUCTION DOCUMENTS